

REFER TO PRECAST PANEL
ELEVATION DRAWINGS FOR
PRECAST PANEL SCHEDULE

LEGEND:

- ⬥ DENOTES COLUMN ABOVE (BOLD TEXT)
⬥ DENOTES COLUMN UNDER
↗ DENOTES SPAN DIRECTION.

SLAB 1 DELTACOR DC200.12 (0,5)

SLAB 2 DELTACOR DC200.12 (2,7)

SLAB 3 DELTACOR DC250.15 (3,10) (NOTE: TOP STRANDS TO BE 9.3 Dia.)

SLAB 5 250 THK SLAB ON FIELDERS KF57 0.75mm BMT

SL102 MESH TOP, THROUGHOUT.

f'c = 40MPa

SLAB 6 180 THK SLAB ON FIELDERS KF57 0.75mm BMT

SL102 MESH TOP, THROUGHOUT.

f'c = 40MPa

300 DENOTES SLAB/BAND BEAM DEPTH

SD DENOTES 80mm SLAB SETDOWN.

REFER TO ARCH. DWG. FOR SETOUT

* DENOTES ROWS OF PROPPING.

TENDER ISSUE

PT Design

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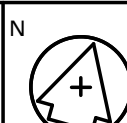
Designer	RW	Drawn	82 & MM
Approved	Approver	Date	02/07/2019 1:00:53 PM
STRUCTURAL		Sheet	4 of 4

Project
**HYDE PARK PLACE
248 UNLEY ROAD,
HYDE PARK SA**

Client
CITYFY & BFC PTY LTD


Drawing Title
**1ST FLOOR LAYOUT
PLAN**

Drawing Number
20492-S06




Scale
1:100

Issue
T

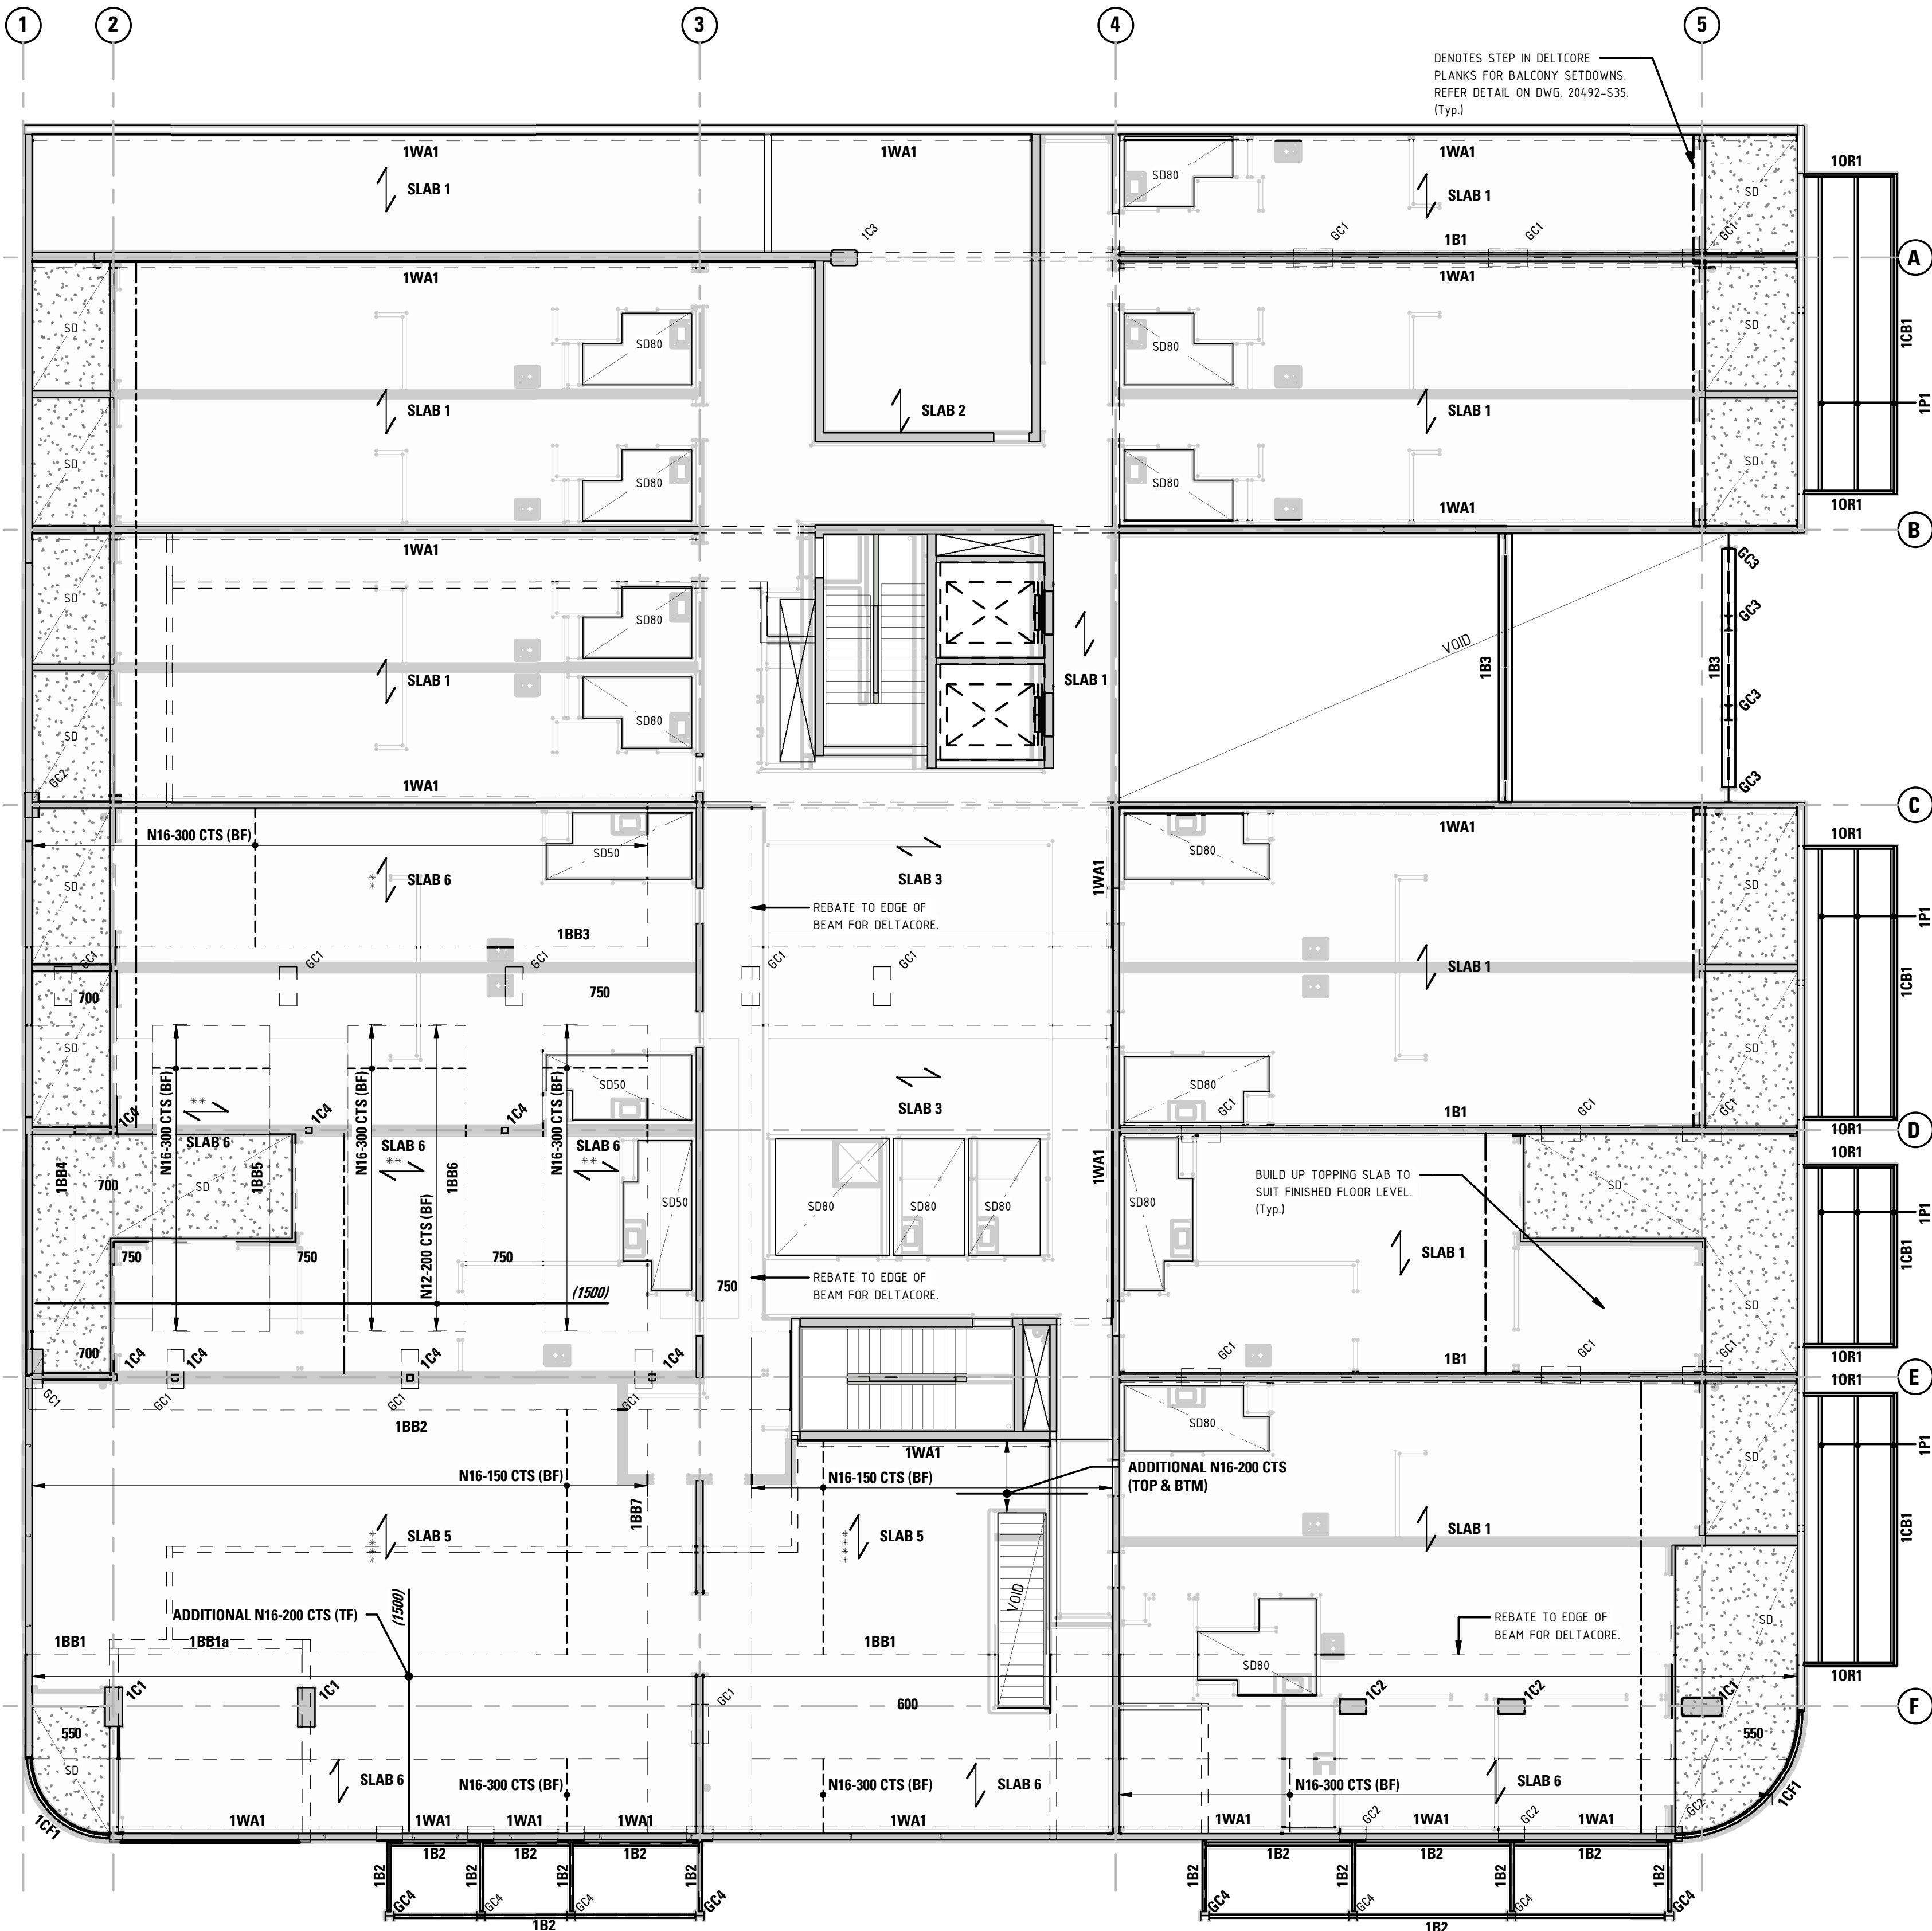

FIRST FLOOR LAYOUT PLAN
SCALE 1:100

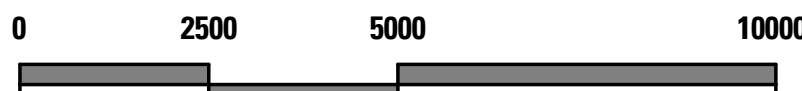

SCALE 1:100 @ A1

CONCRETE COLUMN SCHEDULE (east)

MARK	SIZE	REMARKS
1C1	400 x 900	CONCRETE COLUMN
1C2	600 x 350	CONCRETE COLUMN
1C3	600 x 350	CONCRETE COLUMN
2C1	600 x 350	CONCRETE COLUMN
2C2	600 x 350	CONCRETE COLUMN
BC1	400 x 900	CONCRETE COLUMN
BC2	400 x 900	CONCRETE COLUMN
BC3	600 x 350	CONCRETE COLUMN
CC3	600 x 350	CONCRETE COLUMN
GC1	400 x 900	CONCRETE COLUMN
GC2	600 x 350	CONCRETE COLUMN

1ST FLOOR BAND BEAM SCHEDULE

MARK	SIZE	REMARKS
1BB1	2400W x 600D	BAND BEAM. 18N24 TOP & BTM. FOR DETAILS, REFER DRAWING 20492-S28.
1BB1a	2400W x 300D	BAND BEAM. FOR DETAILS, REFER DRAWING 20492-S28.
1BB2	1800W x 750D	BAND BEAM. 18N24 TOP & BTM. FOR DETAILS, REFER DRAWING 20492-S28.
1BB3	1800W x 750D	BAND BEAM. 18N24 TOP & BTM. FOR DETAILS, REFER DRAWING 20492-S28.
1BB4	1800W x 750D	BAND BEAM. 16N24 TOP & BTM. FOR DETAILS, REFER DRAWING 20492-S28.
1BB5	1800W x 750D	BAND BEAM. 18N28 TOP & BTM. FOR DETAILS, REFER DRAWING 20492-S28.
1BB6	1800W x 750D	BAND BEAM. 18N28 TOP & BTM. FOR DETAILS, REFER DRAWING 20492-S28.
1BB7	2400W x 750D	BAND BEAM. 20N28 TOP & BTM. FOR DETAILS, REFER DRAWING 20492-S28.

STEEL COLUMN SCHEDULE

MARK	SIZE	REMARKS
1C4	150x9.0 SHS	COLUMN.
2C3	150x9.0 SHS	COLUMN.
3C1	150x9.0 SHS	COLUMN.
4C1	150x9.0 SHS	COLUMN.
5C1	150x9.0 SHS	COLUMN.
6C1	89x3.5 SHS	COLUMN.
GC3	360UB4.7	COLUMN.
GC4	200UC46.2	COLUMN.

STEEL FRAMING SCHEDULE

MARK	SIZE	REMARKS
1B1	250UC89.5 + 500W x 16 THK PL.	FLOOR BEAM.
1B2	250 PFC	CANOPY BEAM.
1B3	310UC96.8	BEAM.
1CB1	250 PFC	CANOPY BEAM.
1CF1	75x3.5 SHS	CURVED FASCIA.
1OR1	250 PFC	OUTRIGGER.
1WA1	150x12 EA	WALL ANGLE.
2B1	200UC59.5	FLOOR BEAM.
2B2	250UC89.5	FLOOR BEAM.
2B3	310UB4.0	FLOOR BEAM.
2B4	250UC72.9	FLOOR BEAM.
2B5	310UB4.0	BEAM.
2CF1	75x3.5 SHS	CURVED FASCIA.
2GP1	SC15015	GUTTER PURLIN.
2P1	SZ15015	PURLINS @ 1200 CTS.
2R1	200 PFC	RAFTER.
2WA1	150x12 EA	WALL ANGLE.
3B1	200UC59.5	FLOOR BEAM.
3B2	310UC158	CONTINUOUS FLOOR BEAM.
3B3	250 PFC	FLOOR BEAM.
3B4	200UC59.5	FLOOR BEAM.
3B5	250UC72.9	FLOOR BEAM.
3GP1	SC15015	GUTTER PURLIN.
3P1	SZ15015	PURLINS @ 1200 CTS.
3R1	200 PFC	RAFTER.
3WA1	150x12 EA	WALL ANGLE.
4B1	200UC59.5	FLOOR BEAM.
4B2	250 PFC	FLOOR BEAM.
4B3	200UC59.5	FLOOR BEAM.
4B4	250UC72.9	FLOOR BEAM.
4B5	200 PFC	FLOOR BEAM.
4WA1	150x12 EA	WALL ANGLE.
5B1	200UC59.5	FLOOR BEAM.
5B2	250 PFC	FLOOR BEAM.
5B3	200UC59.5	FLOOR BEAM.
5B4	250UC72.9	FLOOR BEAM.
5B5	200 PFC	FLOOR BEAM.
5WA1	150x12 EA	WALL ANGLE.
6B1	200UC59.5	FLOOR BEAM.
6B2	250 PFC	FLOOR BEAM.
6B3	200UC59.5	FLOOR BEAM.
6B4	250UC72.9	FLOOR BEAM.
6B5	200 PFC	FLOOR BEAM.
6WA1	150x12 EA	WALL ANGLE.
RA1	100x10 EA	RAKING ANGLE.